



**VARIOUS PRODUCT APPROVALS**

PRODUCT	APPROVAL
CONCRETE	1.000
STEEL	1.000
GLASS	1.000
PAINTS	1.000
ROOFING	1.000
MECHANICAL	1.000
ELECTRICAL	1.000
PLUMBING	1.000
INSULATION	1.000
CEILING	1.000
FLOORING	1.000
WALLS	1.000
DOORS	1.000
WINDOWS	1.000
ROOFING	1.000
MECHANICAL	1.000
ELECTRICAL	1.000
PLUMBING	1.000
INSULATION	1.000
CEILING	1.000
FLOORING	1.000
WALLS	1.000
DOORS	1.000
WINDOWS	1.000

**REINFORCING STEEL:**

- All reinforcing steel shall conform to the requirements of ASTM A618 Grade 60 or ASTM A631 Grade 60.
- All welded wire fabric shall conform to the requirements of ASTM A185.
- All reinforcing steel shall be protected with a minimum of 1/2" concrete cover.

**ROOF FINISHES:**

- Roofing shall be installed in accordance with the manufacturer's instructions.
- Roofing shall be installed over a minimum of 1/2" concrete or 1" gypsum board.

**CONCRETE FINISHES:**

- All concrete shall be finished with a minimum of 1/2" concrete cover.
- Concrete shall be finished with a minimum of 1/2" concrete cover.

**CONSTRUCTION:**

- All construction shall be in accordance with the building code.
- All construction shall be in accordance with the building code.

**SHOP DRAWINGS:**

- All shop drawings shall be submitted to the architect for review.
- All shop drawings shall be submitted to the architect for review.

**FOUNDATION:**

- All foundation shall be in accordance with the building code.
- All foundation shall be in accordance with the building code.

**STRUCTURAL CONCRETE:**

- All structural concrete shall be in accordance with the building code.
- All structural concrete shall be in accordance with the building code.

**WOOD FINISHES:**

- All wood finishes shall be in accordance with the building code.
- All wood finishes shall be in accordance with the building code.

**STEEL CONNECTION NOTES:**

- All steel connections shall be in accordance with the building code.
- All steel connections shall be in accordance with the building code.

**DESIGN CRITERIA**

1. The building shall be designed in accordance with the Florida Building Code.

2. The building shall be designed in accordance with the Florida Building Code.

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10. The building shall be designed in accordance with the Florida Building Code.

**LIST OF ABBREVIATIONS**

SYMBOL	DESCRIPTION
1	1/2" CONC
2	1" CONC
3	2" CONC
4	3" CONC
5	4" CONC
6	5" CONC
7	6" CONC
8	7" CONC
9	8" CONC
10	9" CONC
11	10" CONC
12	11" CONC
13	12" CONC
14	13" CONC
15	14" CONC
16	15" CONC
17	16" CONC
18	17" CONC
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93	92" CONC
94	93" CONC
95	94" CONC
96	95" CONC
97	96" CONC
98	97" CONC
99	98" CONC
100	99" CONC

**BUILDING ELEVATIONS**


**CUSTOM RESIDENCE**  
MONTESSA, FL

**DESIGNER:** Daniel F. Ardito, P.E.  
**DATE:** 11/11/2011  
**PROJECT:** CUSTOM RESIDENCE  
**SCALE:** AS SHOWN  
**SHEET:** 1 OF 8








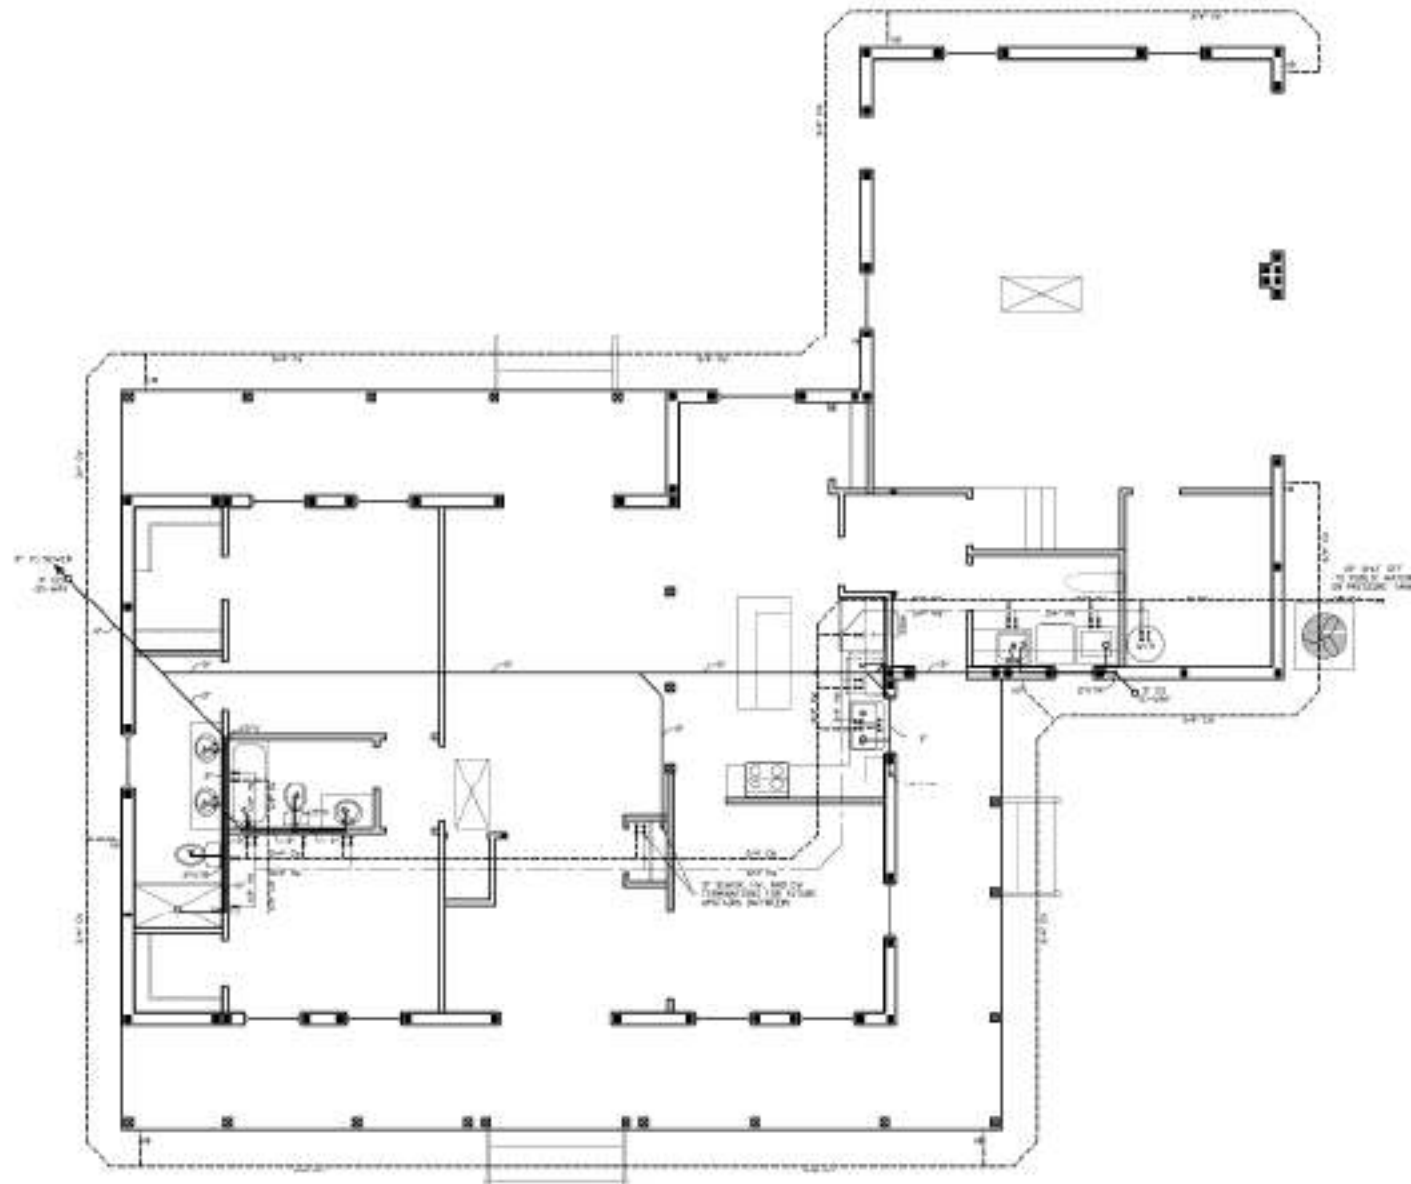


PLUMBING PLAN  
GENERAL

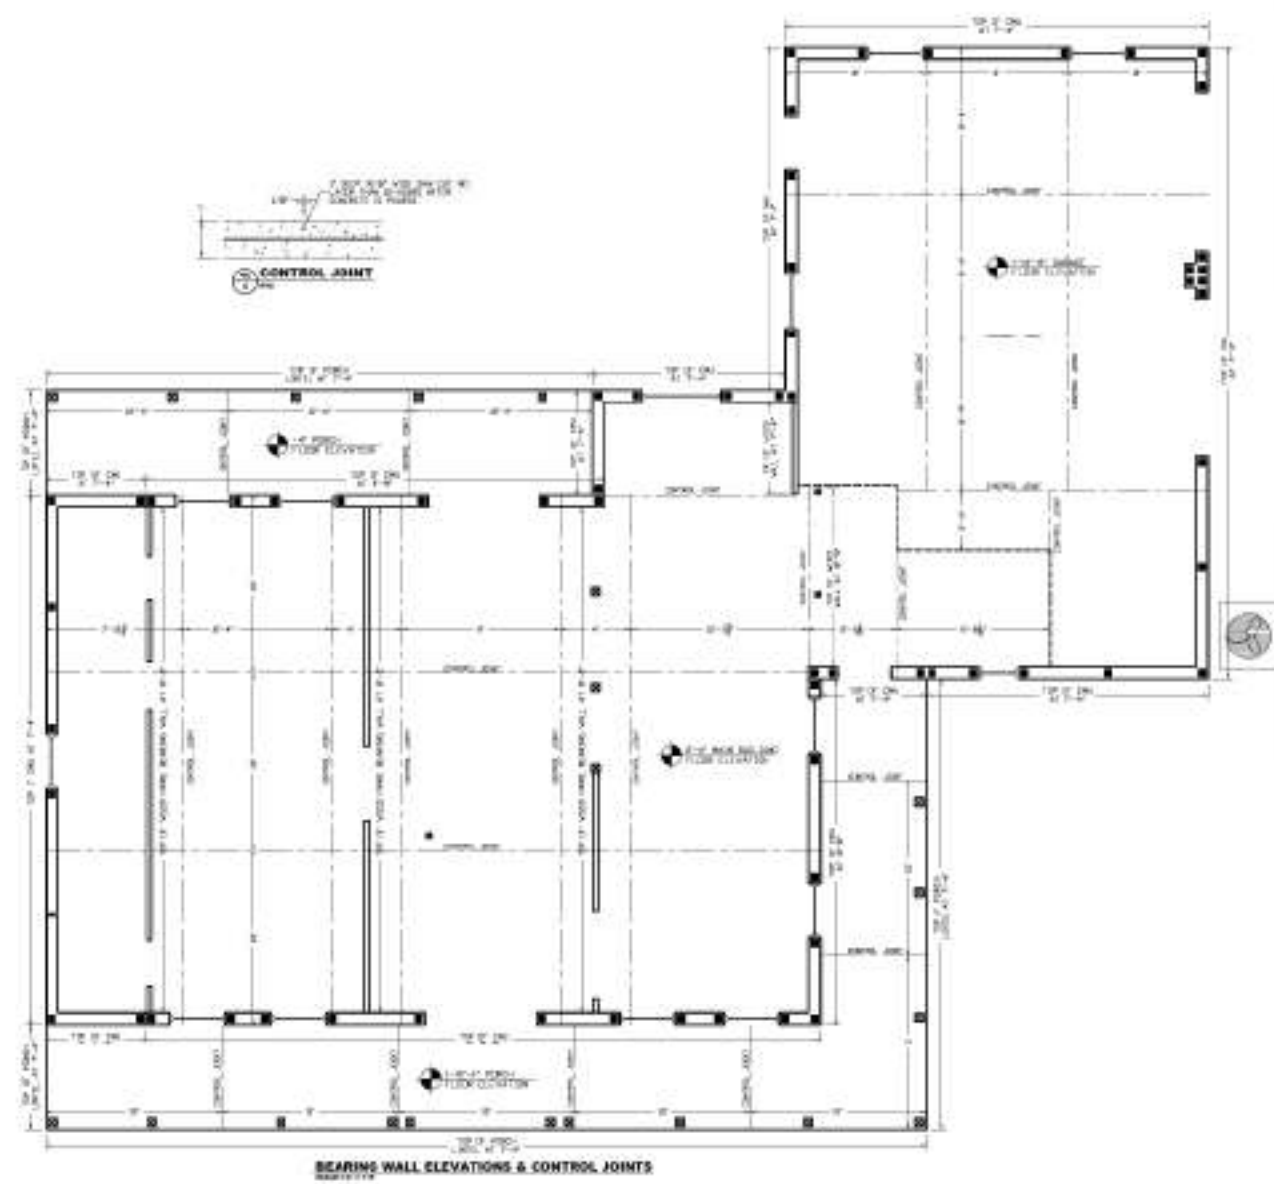

BEARING WALL ELEVATIONS & CONTROL JOINTS

**HEAT WATER HEATER NOTES**


1. AN APPROXIMATE AREA AS A GUIDE TO THE AREA OF THE HEATER SHALL BE PROVIDED TO INDICATE THE LOCATION OF THE HEATER. THE HEATER SHALL BE PROVIDED TO INDICATE THE LOCATION OF THE HEATER.
2. THE HEATER SHALL BE PROVIDED TO INDICATE THE LOCATION OF THE HEATER.
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WATER HEATER LINKAGE

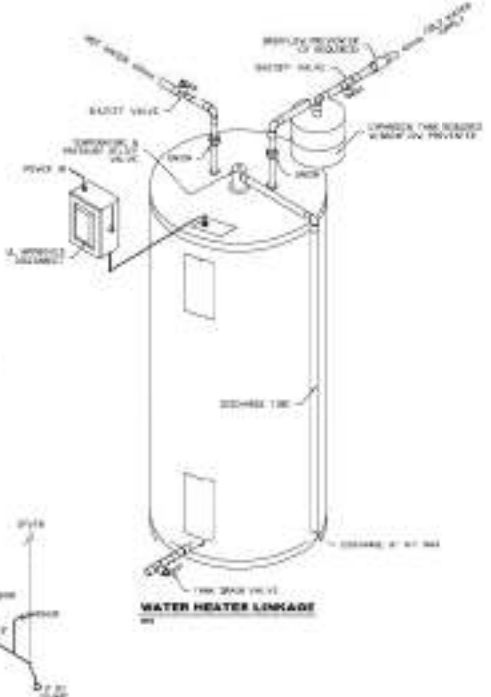**PLUMBING NOTES**

1. EXISTING PLUMBING SHALL BE MAINTAINED UNLESS OTHERWISE NOTED.
2. ALL PLUMBING SHALL BE INSTALLED IN ACCORDANCE WITH THE PLUMBING CODE.
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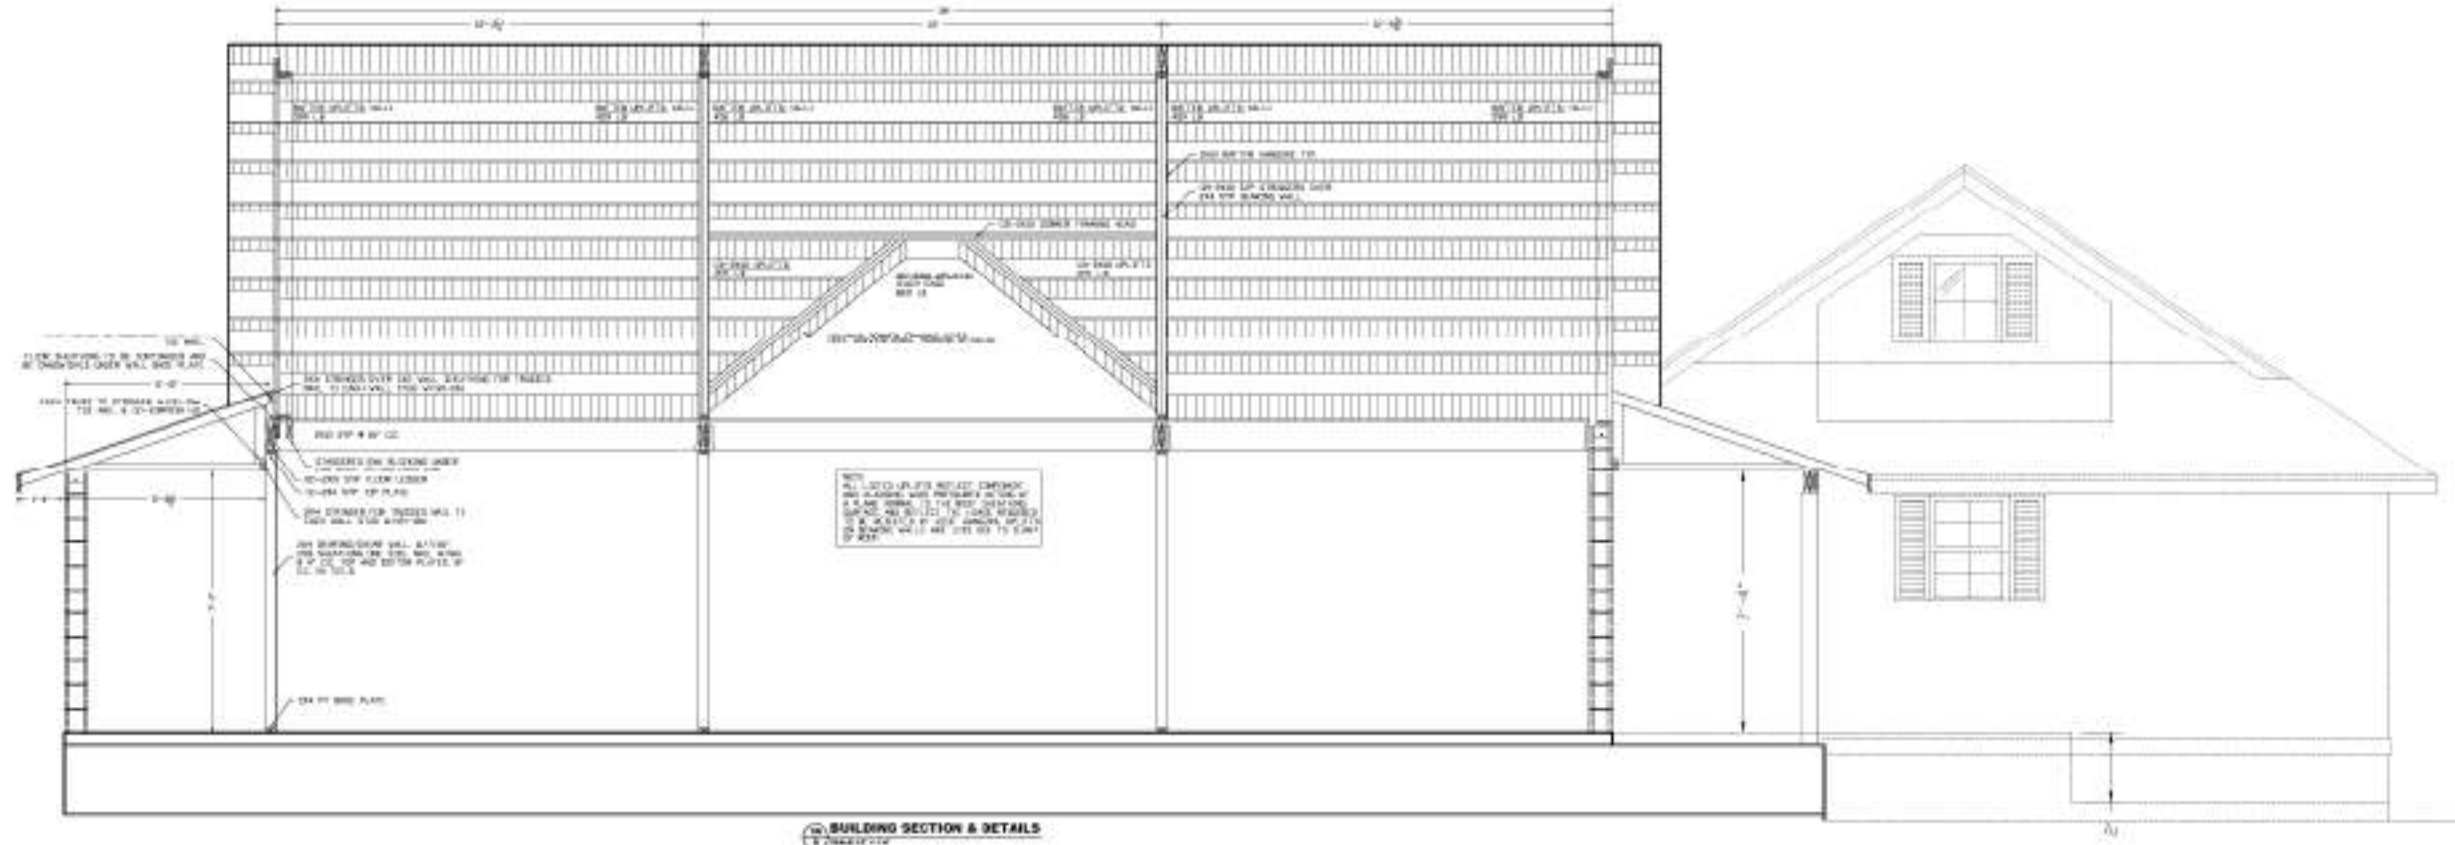


PLUMBING ISOMETRIC


SHEET	4
	OF 8
JOB NAME	CUSTOM RESIDENCE HENDASSA, FL
SHEET TITLE	PLUMBING PLAN
DATE	02/20/20
DESIGNER	DAVID F. ANDERSON, P.E.
CHECKER	DAVID F. ANDERSON, P.E.
DATE	02/20/20
SCALE	AS SHOWN
PROJECT NO.	123-123

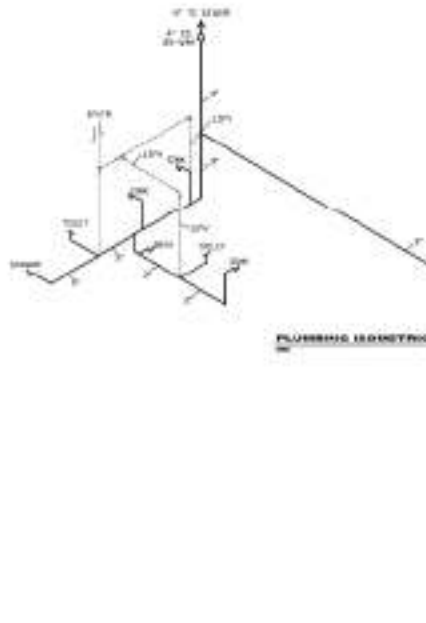David F. Anderson, P.E.  
Florida Reg. 12345






BUILDING SECTION & DETAILS

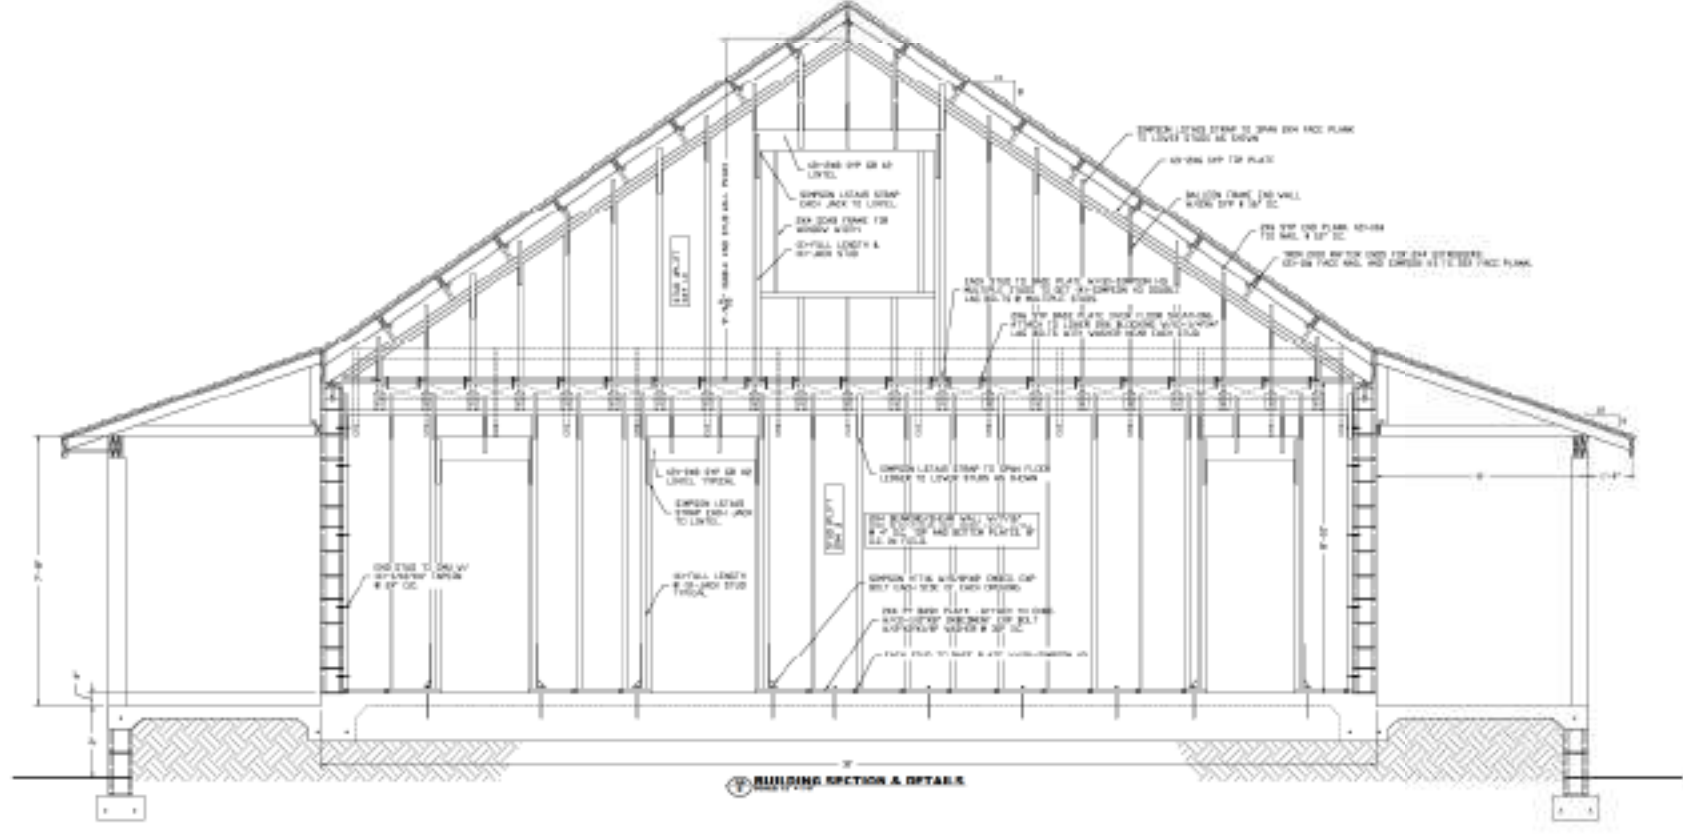


BUILDING SECTION & DETAILS

SHEET 3 OF 8	JOB NAME CUSTOM RESIDENCE HENDOSASSA, FL	SHEET TITLE BUILDING SECTIONS	DATE 12/15/2015	SCALE AS SHOWN
			DESIGNED BY DANIEL F. ANDRUS, P.E.	CHECKED BY DANIEL F. ANDRUS, P.E.
Daniel F. Andrus, P.E. Professional Engineer License No. 12000 State of Florida			DATE 12/15/2015	SCALE AS SHOWN

Daniel F. Andrus, P.E.  
Florida Reg. 12000

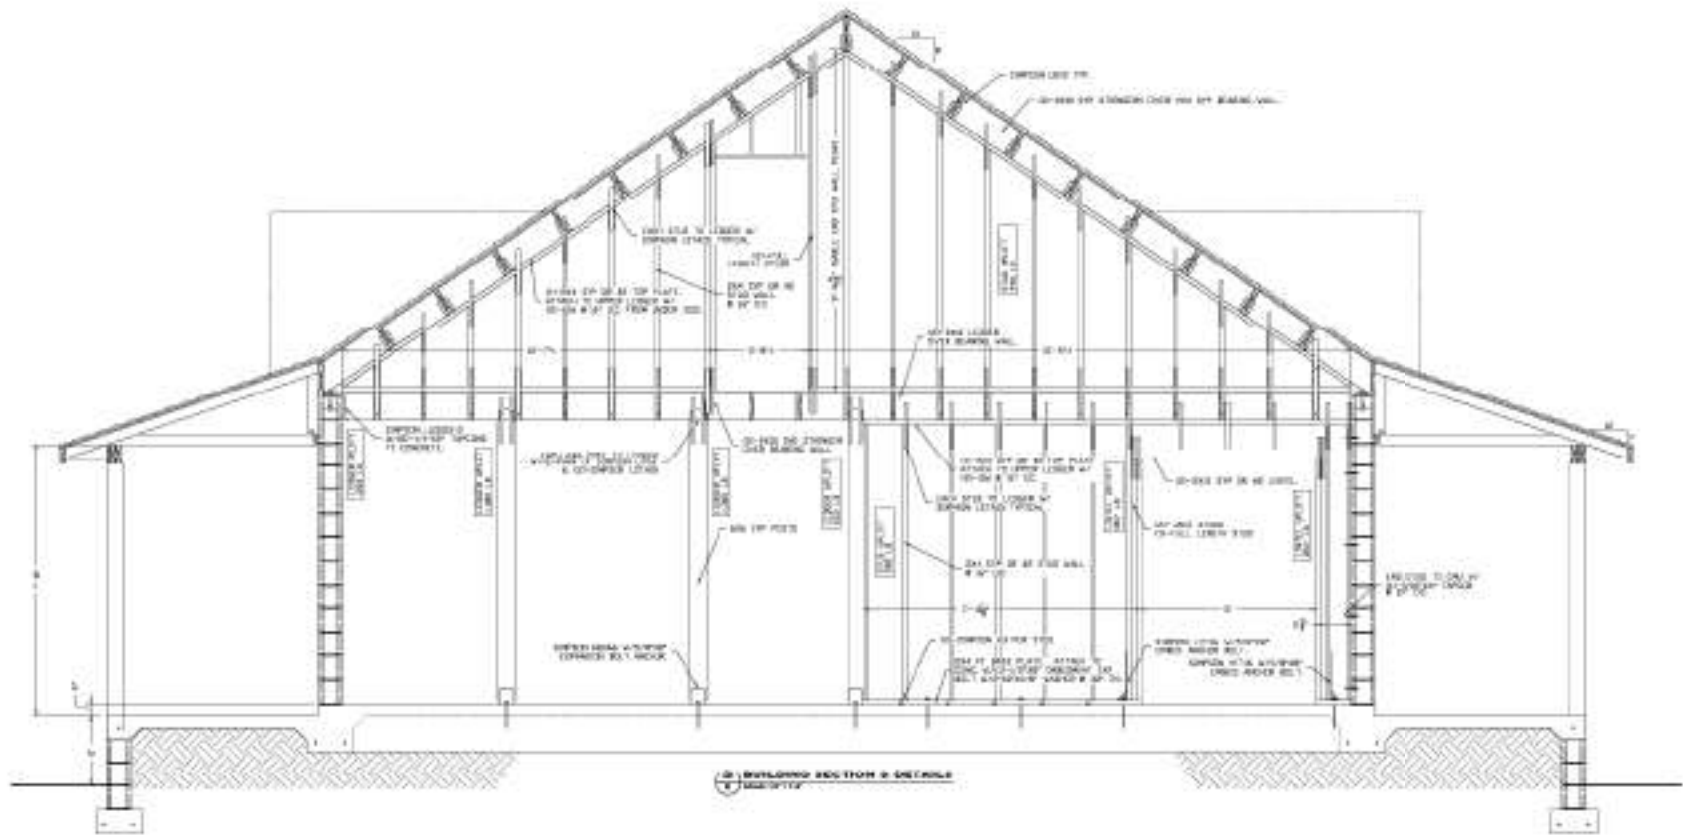

BUILDING SECTION & DETAILS

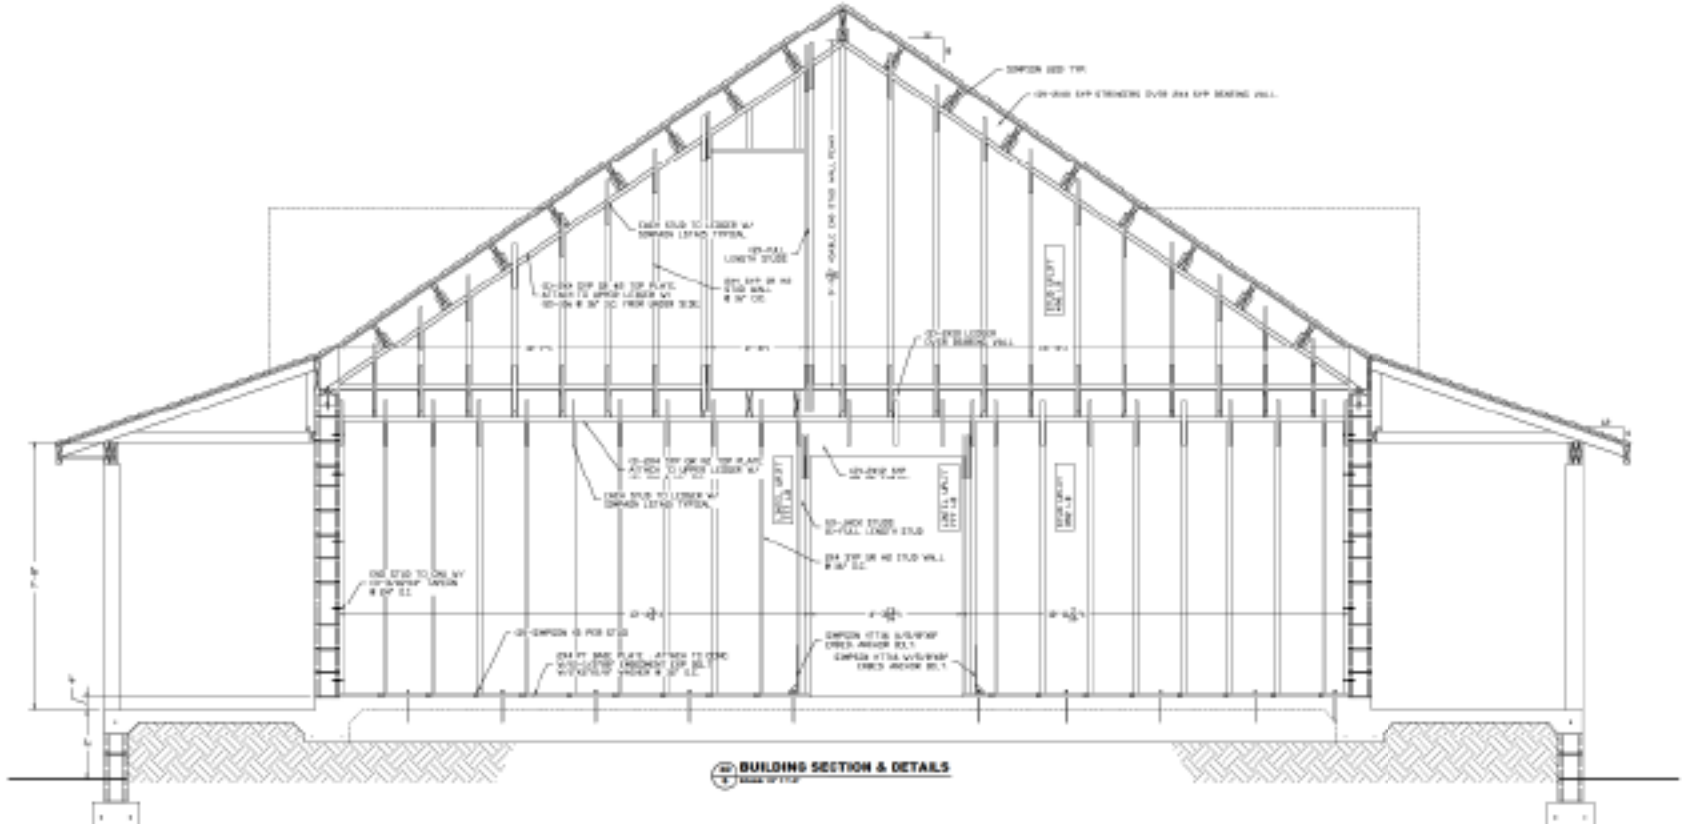

BUILDING SECTION & DETAILS

David F. Avella, P.E.  
Florida Reg. 10000

SHEET  
6  
of 8

JOB NAME  
CUSTOM RESIDENCE  
HENDOSATTA, FL


SHEET TITLE

BUILDING SECTIONS


David F. Avella, P.E.  
Professional Engineer  
No. 10000  
FLORIDA  
10/15/2010

DATE  
DRAWN BY  
DATE REVISION


NO.  
DATE

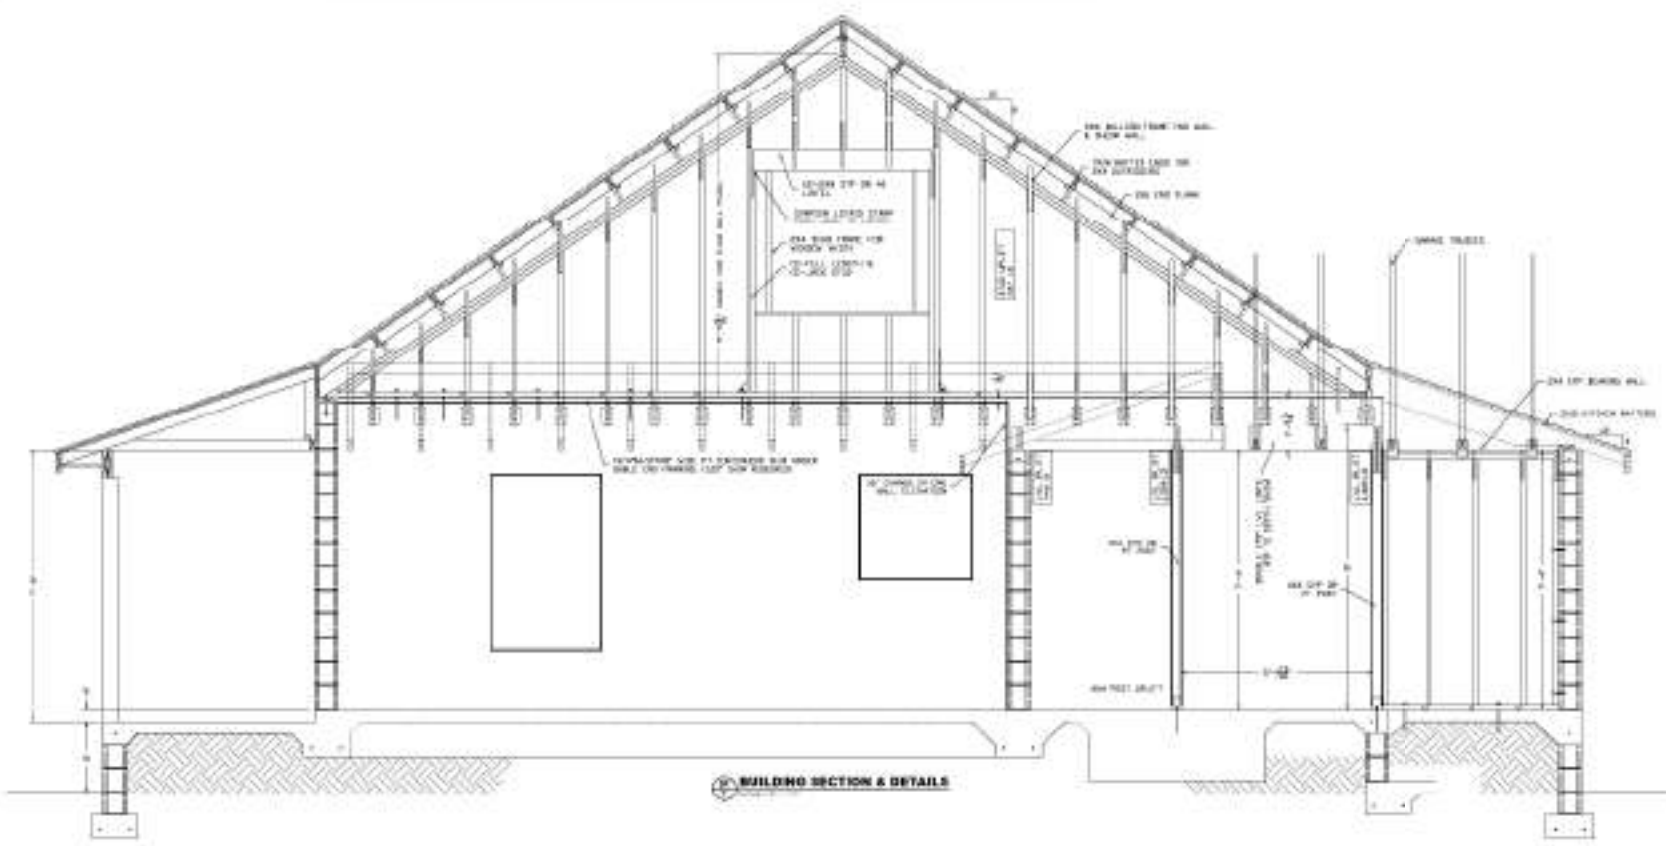

BUILDING SECTION & DETAILS

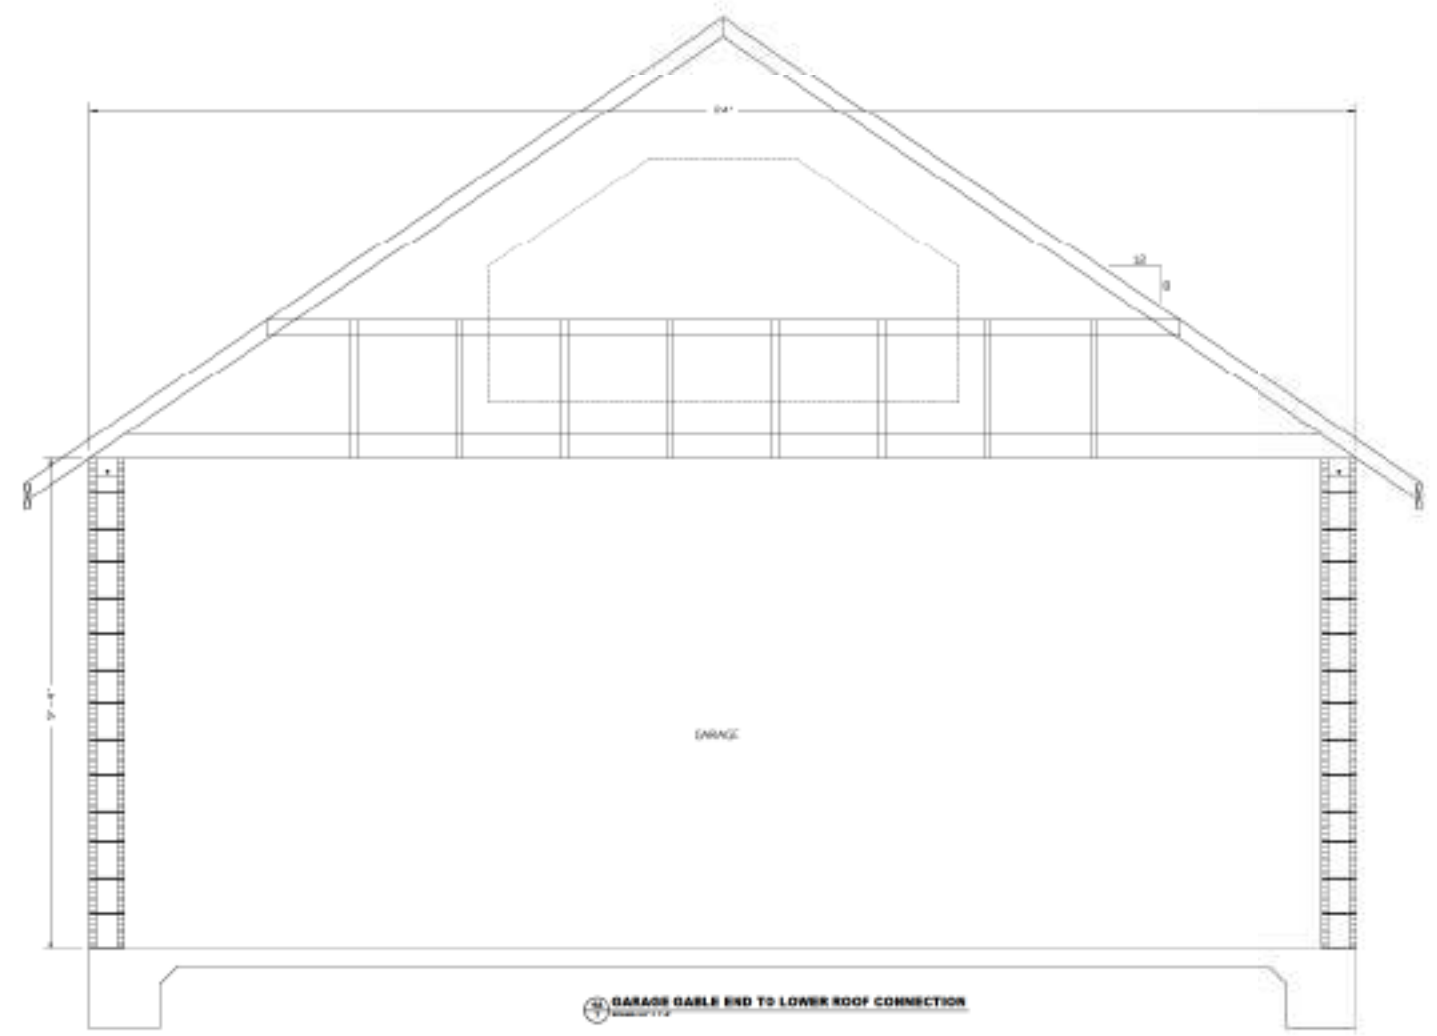


GARAGE GABLE END TO LOWER ROOF CONNECTION

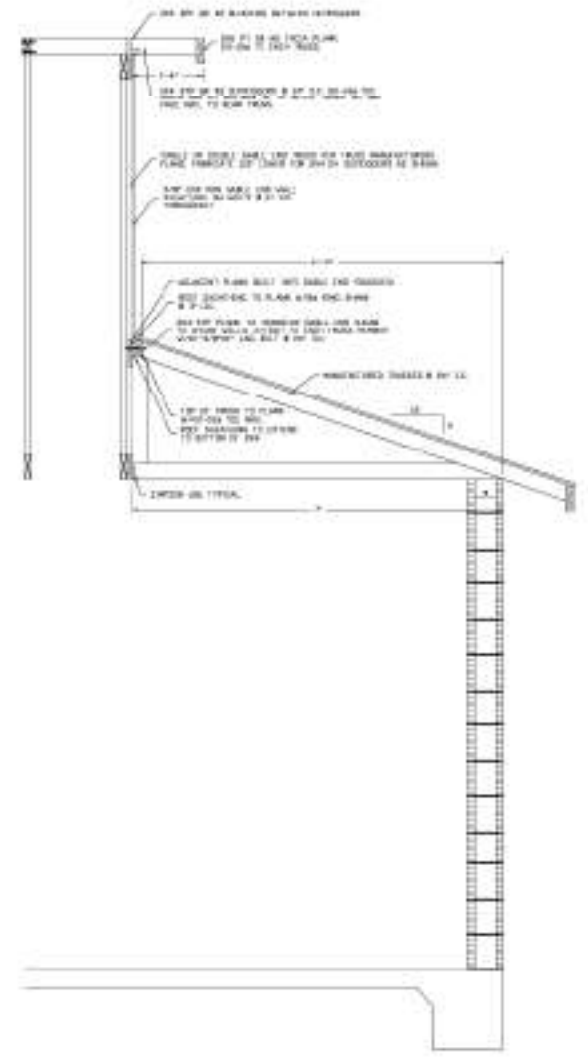


David F. Nix, P.E.  
Florida Registered Professional Engineer  
No. 12111

SHEET /	JOB NAME CUSTOM RESIDENCE HENDOSASSA, FL	SHEET TITLE BUILDING SECTIONS	DATE	DATE	DATE
			2024-08-15	2024-08-15	2024-08-15
OF 8			OWNER	DESIGNER	DATE
			2024-08-15	2024-08-15	2024-08-15

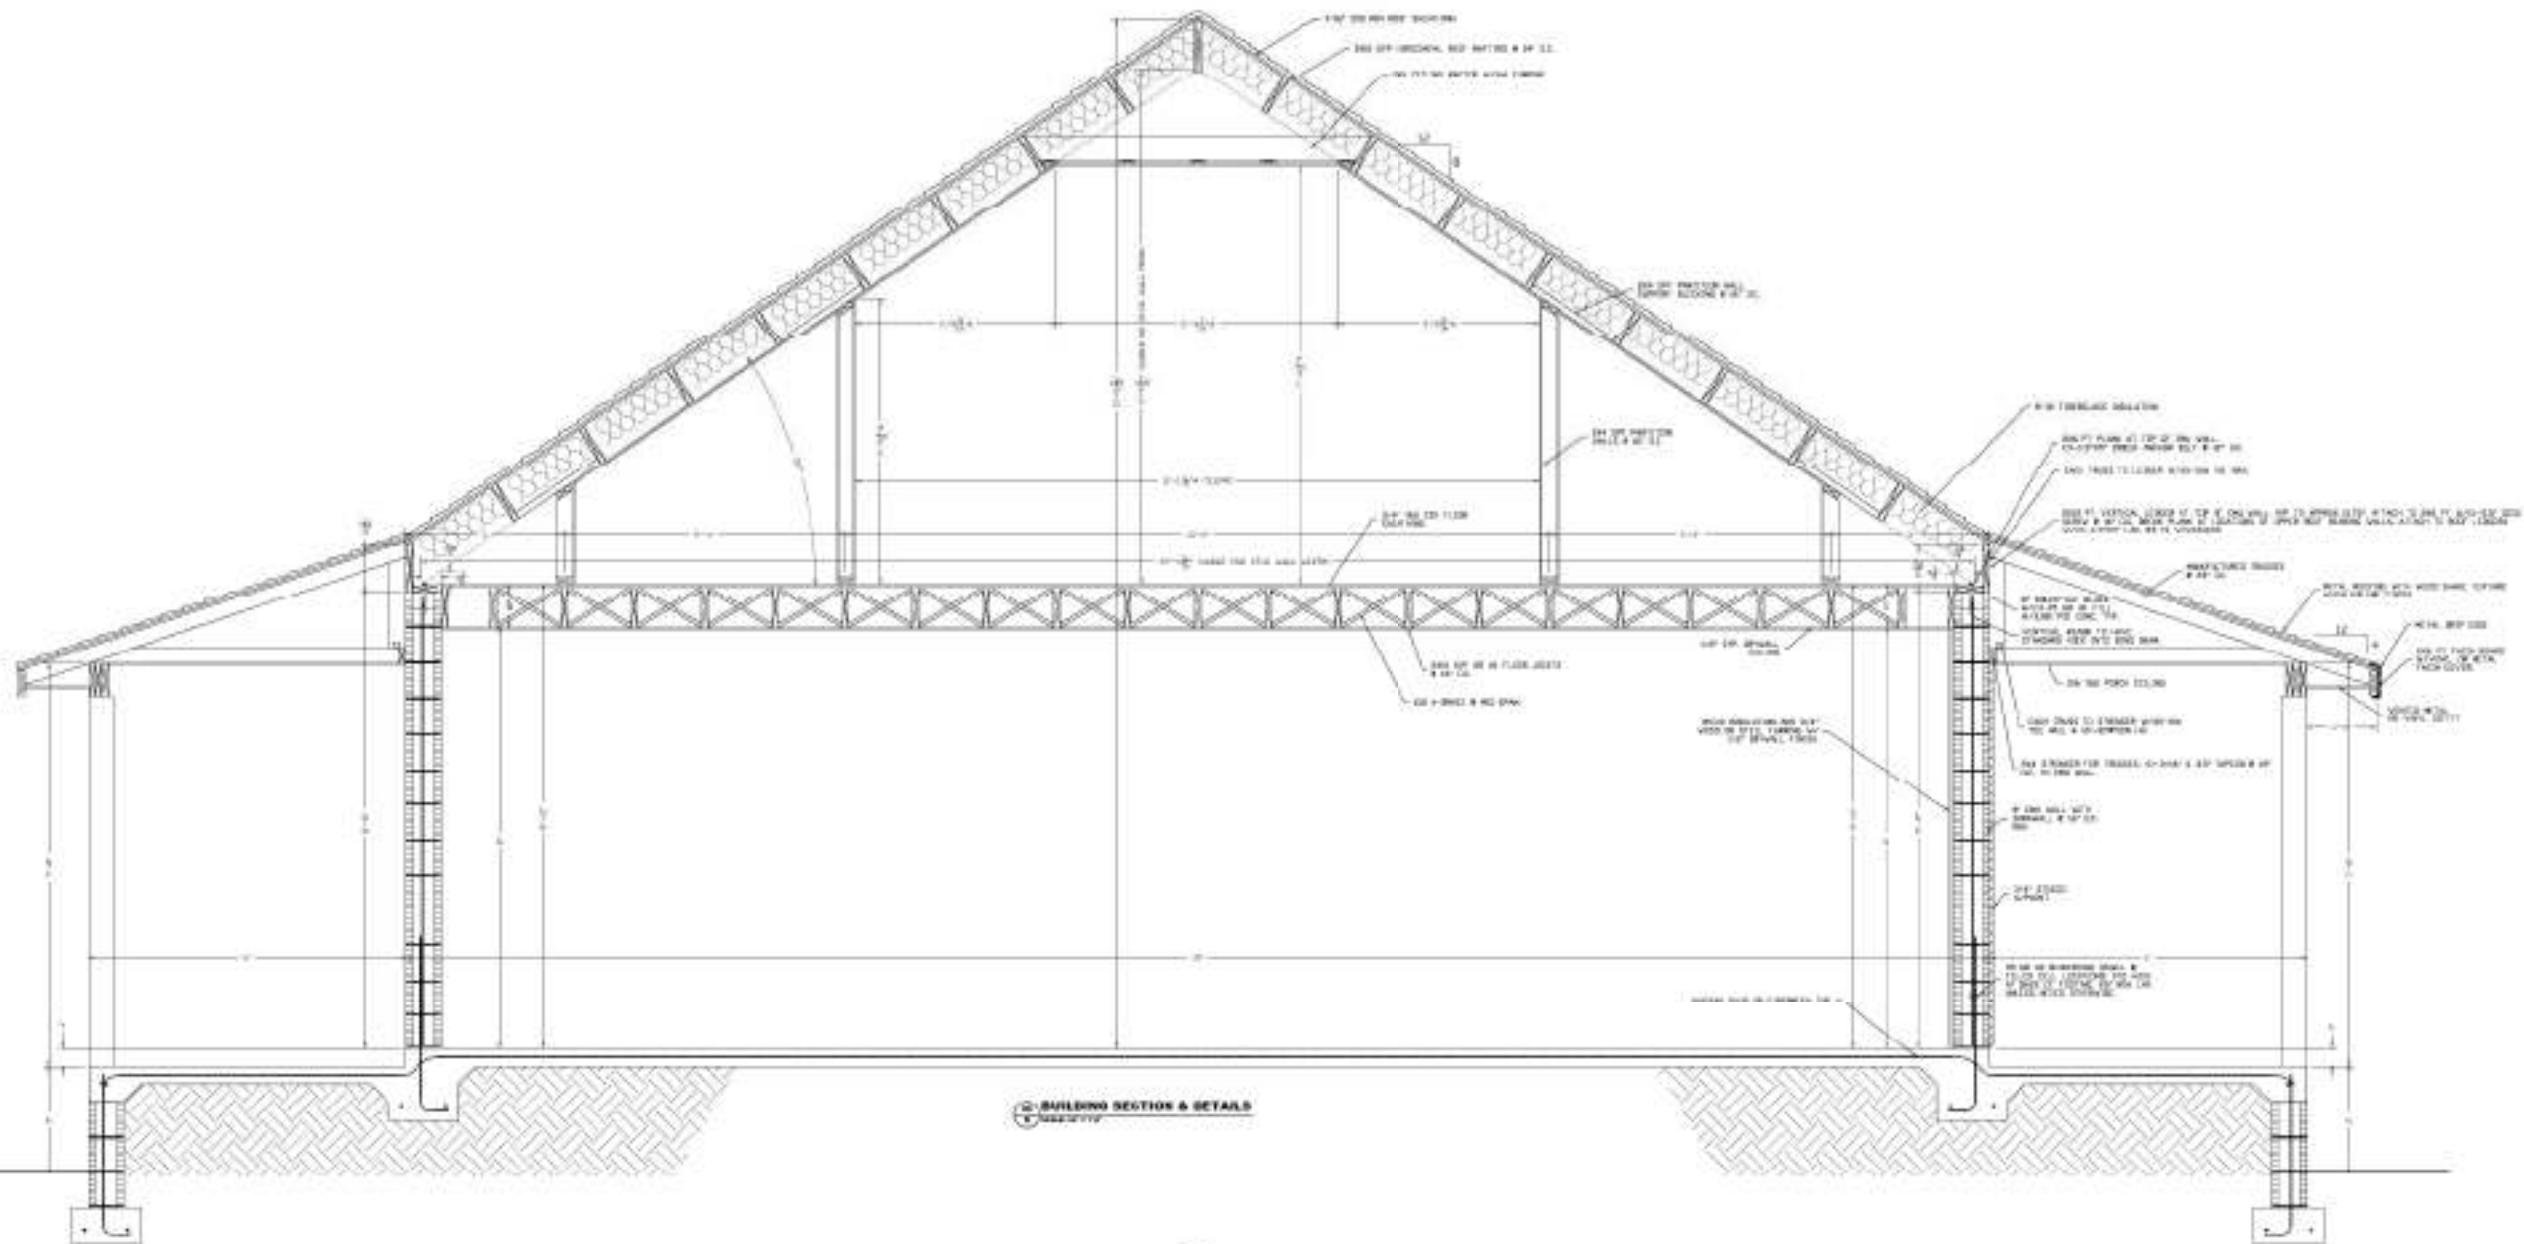

12 BUILDING SECTION & DETAILS

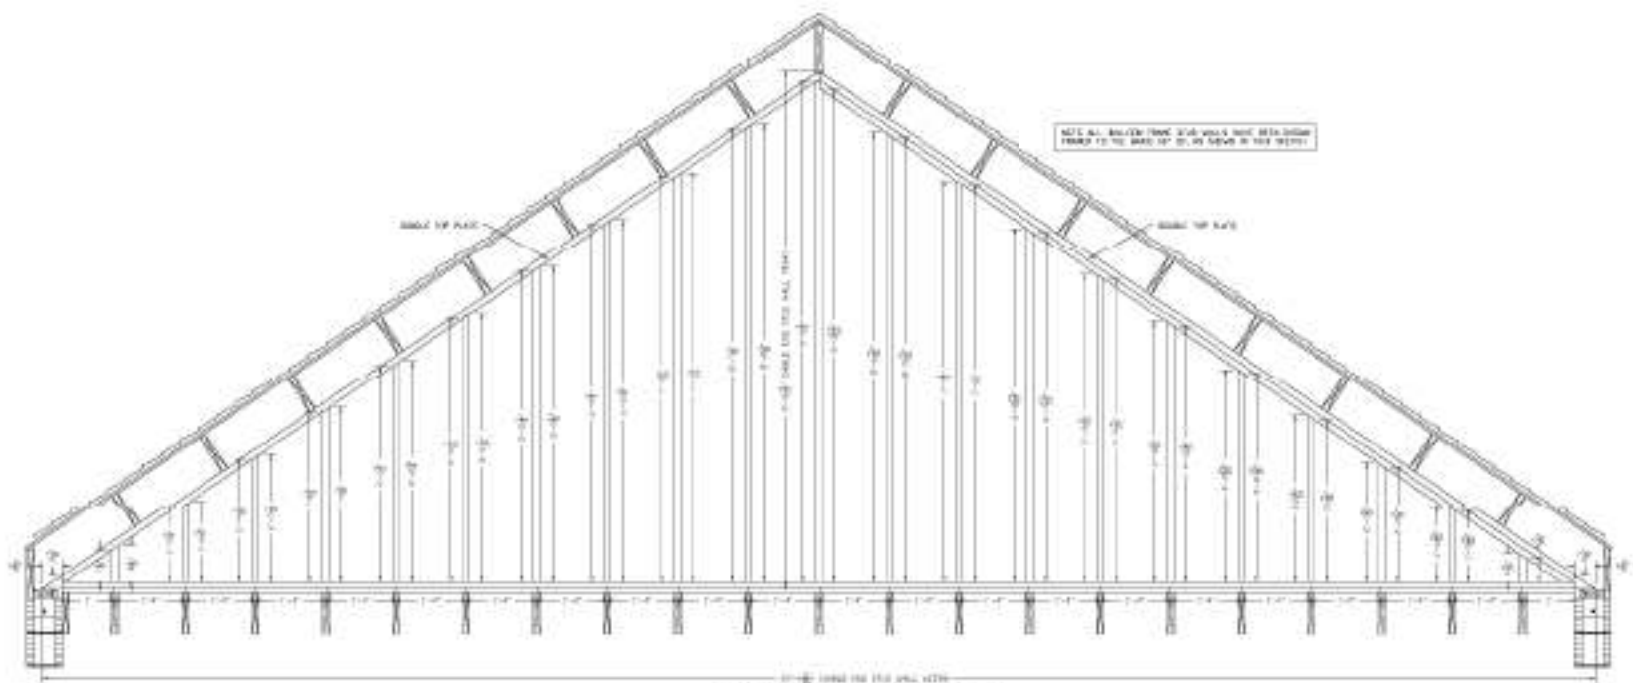

13 BALLOON FRAME WALL DIMENSIONS

DATE	11/11/2011
SCALE	AS SHOWN
PROJECT	111-111

David F. Nix, P.E.  
Professional Engineer  
No. 11111  
State of Florida  
111-111

SHEET TITLE  
**BUILDING SECTIONS**

JOB NAME  
**CUSTOM RESIDENCE**  
MENDOCINO, CA

SHEET  
**8**  
OF 8

David F. Nix, P.E.  
11111